
## PHOTOVOLTAIC SYSTEM

2,592 MODULES - PARKING CANOPY - 984.96 kWDC, 726.0 kWAC 301 EAST OAK AVENUE, LAWNSIDE, NJ 08045

OWNER/APPLICANT: BT-NEWYO, LLC ATTN: RAY CHESNA 55 GLENLAKE PARKWAY ATLANTA, GA 30328

DRAWING REVISION:


# FINAL SITE PLAN

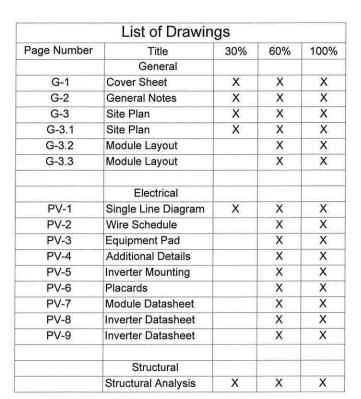


#### **BOROUGH CERTIFICATIONS**

THIS PLAN IS HEREBY APPROVED BY THE PLANNING BOARD OF THE BOROUGH OF LAWNSIDE

PLANNING BOARD CHAIRPERSON	DATE
PLANNING BOARD SECRETARY	DATE
PLANNING BOARD ENGINEER	DATE

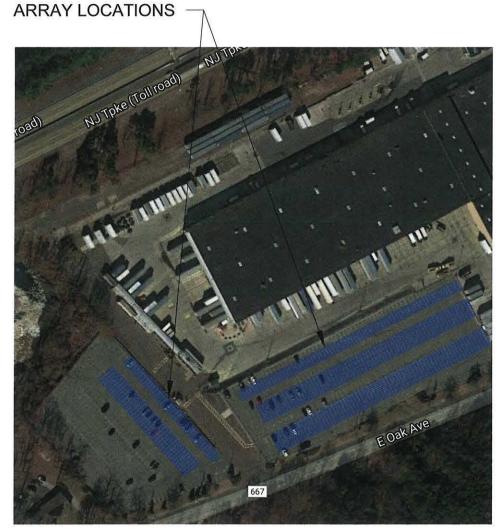



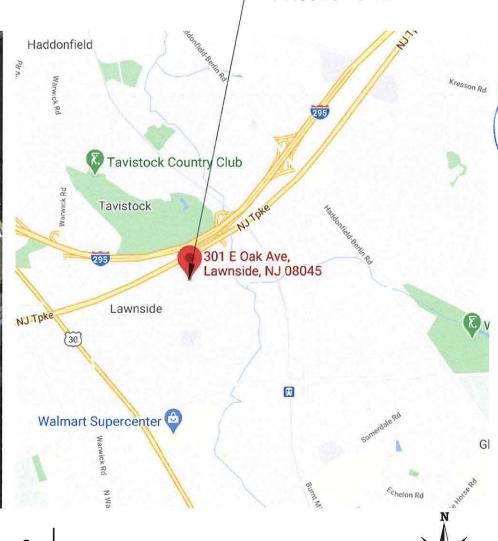

**PROJECT SITE** 





#### dGEN Energy Partners

PHONE: (574)-904-4477 Website: www.dgenenergy.com Address: 30 N Gould St, Suite 5736

DESCRIPTION	DATE	REV
30% SET	04/04/2020	1
60% SET	09/09/2020	2
100% SET	12/21/2020	3.1

NC NC  $\exists$ 

08045

Lawnside,

SERVICE Oak PARCEL UNITED

SHEET NAME

**COVER SHEET** 

SHEET SIZE

ARCH D 36" X 24"

SHEET NUMBER G-1

## PHOTOVOLTAIC SYSTEM

2,592 MODULES - PARKING CANOPY - 984.96 kWDC, 726.0 kWAC 301 EAST OAK AVENUE, LAWNSIDE, NJ 08045

#### **GENERAL NOTES**

- 1. ALL PANELS, SWITCHES, ETC. SHALL HAVE SUFFICIENT GUTTER SPACE AND LUGS IN COMPLIANCE TO UL REQUIREMENTS TO ACCOMMODATE CONDUCTORS SHOWN.
- THIS SYSTEM WILL NOT BE INTERCONNECTED UNTIL APPROVAL FROM THE LOCAL JURISDICTION AND THE UTILITY IS OBTAINED. THIS IS A UTILITY INTERACTIVE SYSTEM WITH NO STORAGE BATTERIES.
- ALL EXTERIOR ELECTRICAL DEVICES AND EQUIPMENT INCLUDING THOSE THAT ARE EXPOSED TO OUTSIDE ENVIRONMENT SHALL BE WEATHERPROOF TYPE NEMA 3R AND SHALL BE LISTED BY "UL" FOR THE TYPE OF APPLICATION AND "UL" LABEL SHALL APPEAR ON ALL ELECTRICAL EQUIPMENT.
- WIRING METHOD SHALL BE EMT ABOVE GROUND MOUNTED IN CONCEALED SPACES (UNLESS APPROVED OTHERWISE) AND SCHEDULE- 40 PVC FOR BELOW GROUND INSTALLATION UNLESS NOTED OTHERWISE.
- AN OSHA APPROVED LADDER PROVIDING ACCESS TO ALL PORTIONS OF THE ARRAY SHALL BE SECURED PRIOR TO REQUESTING INSPECTION.
- SOLAR MODULES MOUNTED ON CANOPY.
- CONNECT SYSTEM TO MAIN PANEL VIA PV BREAKER. IF THE EXISTING MAIN SERVICE PANEL DOES NOT HAVE VERIFIABLE GROUNDING ELECTRODE, IT IS THE CONTRACTOR'S RESPONSIBILITY TO INSTALL A SUPPLEMENTAL GROUNDING ELECTRODE.
- COMPLY WITH STATE AND LOCAL CODES, AND UTILITY COMPANY REGULATIONS, FINAL INTERPRETATIONS WILL BE MADE BY THE LOCAL INSPECTION AUTHORITY (AHJ). THE CONTRACTOR TO VERIFY THE GOVERNANCE OF THE FOLLOWING CODES AFFIXED TO THIS SHEET, INCLUDING ANY AMENDMENTS AND SUPPLEMENTARY CODES.
- EQUIPMENT AND MATERIALS SHALL BE NEW. UL-LISTED FOR THE INTENDED USE, AND FREE FROM DAMAGE OR DEFECT. THEY SHALL COMPLY WITH THE LATEST INDUSTRY STANDARDS, INCLUDING UL1703 (PANELS AND/OR FRAME SUPPORT), UL 1704 (INVERTERS), UL 1741 (COMBINER BOXES, ETC.).
- 10. ALL COMPONENTS SHALL BE RATED FOR USE IN THE ENVIRONMENT IN WHICH THEY ARE INSTALLED. THIS INCLUDES UV RATING FOR EXTERIOR WIRING. WIRING SUPPORTS, CONNECTORS, INVERTERS, COMBINERS, ETC. STEEL LOCATED OUTDOORS SHALL BE GALVANIZED (NOT PAINTED).

- CONDUCTORS SHALL BE COPPER, SIZED ACCORDING TO FEEDER SCHEDULE FOUND IN THIS DRAWING SET. AND RATED FOR 90C. SEE DRAWING FOR ROUTING.
- COLOR CODING TO BE AS FOLLOWS: A. CURRENT CARRYING DC WIRES SHALL BE RED (POS), AND BLACK (UNGROUNDED NEG.), B. CURRENT CARRYING AC SHALL BE COLOR CODED PER THE NEC. AND C. GROUND WIRES SHALL BE BARE OR GREEN.

#### PHOTOVOLTAIC PANELS

- 1. THE PANEL MANUFACTURER IS RESPONSIBLE FOR THE DESIGN OF THE PANELS AND THE DESIGN OF THE PANEL CONNECTIONS TO THE STRUCTURE INCLUDING ALL COMPONENTS REQUIRED TO MAKE CONNECTIONS. PHOTOVOLTAIC PANELS, COMPONENTS, AND CONNECTIONS SHALL BE DESIGNED TO SUPPORT PANEL WEIGHT PLUS SNOW, WIND, OR SEISMIC LOADING, WHICHEVER COMBINATION PRODUCES THE MOST SEVERE CONDITION IN ACCORDANCE WITH THE INTERNATIONAL BUILDING CODE.
- 2. MODULES SHALL BE LISTED IN CONFORMANCE WITH UL 1703.

#### LUGS

LUGS IN ALL EQUIPMENT WILL BE RATED FOR THE USE. LUGS WILL BE SUITABLE FOR COPPER OR ALUMINUM CONDUCTORS, RATED FOR 75C.

#### GRID-TIED INVERTERS

- INVERTERS SHALL BE DC TO 60 CYCLE AC POWER. THE WATTAGES OF RESPECTIVE INVERTERS SHALL BE AS SHOWN ON THE DRAWINGS.
- 2. INVERTERS SHALL BE CERTIFIED TO UL 1741.

#### START UP PROCEDURES

1. FOLLOW MANUFACTURER'S RECOMMENDED PROCEDURES IN STARTING UP THE EQUIPMENT.

#### ZONING SCHEDULE / BULK CHART

ZONE:	GOVERNED BY THE OAK AVENUE REDEVELOPMENT PLAN AND THE UNDERLYING ZONING I-A INDUSTRIAL DISTRICT		
STANDARD	REQUIRED	PROPOSED	
MINIMUM LOT AREA	2 ACRES	EXISTING LOT 34 ACRES	
MAXIMUM HEIGHT	40 FT	18 FT	
FRONT YARD	30 FT	45 FT	
REAR YARD	30 FT	650 FT	
SIDE YARD	30 FT	55 FT	

HEIGHT MAY NOT EXCEED HEIGHT OF THE PRIMARY STRUCTURE THAT THE PARKING AREA SERVES, EXISTING UPS FACILITY HEIGHT: 30 FT.

#### ADOPTED CODES, BOROUGH OF LAWNSIDE

- 1. 2018 EDITION OF THE INTERNATIONAL BUILDING CODE (IBC) NJ ED
- 2017 NEW JERSEY BUILDING CODE
- MINIMUM DESIGN LOADS FOR BUILDINGS AND OTHER STRUCTURES (ASCE 7-10)
- 2016 EDITION OF COLD-FORMED STEEL DESIGN SPECIFICATION ADOPTED BY THE LOCAL GOVERNING AGENCIES.
- 5. 2017 NATIONAL ELECTRIC CODE (NEC)

	LIS	ST 13	6 200 FT BLOCK 4	05 LOT 1
BLOCK	LOT	CLA	PROPERTY OWNER	PROPERTY LOCATION
601	1	1	VCC LAWNSIDE BUS PK I REN LLC 228 LANDIS AVE ST 300, VINELAND, NJ 08360	101 WALTER A GAINES
601	2	×1	STATION OAK PARTNERS URBAN RENEWAL 600 S LIVINGSTON AVE #102, LIVINGSTON, NJ 07039	402 E OAK AVENUE
701	1	1	NEW JERSEY AMERICAN WATER CO INC 1025 LAUREL OAK RD, VOORHEES, NJ 08043	100 WALTER A GAINE: WAY
1003	2	1	VINELAND CONSTRUCTION CO PO BOX 1517, VINELAND, NJ 08362	ALONG TURNPIKE
1003	3	4A	STILL, JR ELMER ETAL 4303 VILLAGE BRIDGE, LINDENWOLD, NJ 08021	43 DOCTOR MLK JG ROAD

#### **TERMS AND ABBREVIATIONS**

TERM

**ABBRV** 

	NEW WORLD
(#)	NUMERICAL QUANTITIES WHEN ENCLOSED IN PARENTHESES
415	ENCLOSED IN PARENTHESES
A\E AB	ARCHITECT/ENGINEER ANCHOR BOLT
ABC	AGGREGATE BASE COURSE
ARCH	ARCHITECT
ASTM	AMERICAN SOCIETY FOR
00000	TESTING AND MATERIALS
BOD	TESTING AND MATERIALS BOTTOM OF DECK
BOS	BOTTOM OF STEEL
BRG	BEARING
CD	CONTRACT DOCUMENTS
CIP	CAST-IN-PLACE CONSTRUCTION JOINT
Cl	CONSTRUCTION JOINT
CI.	CONTROL JOINT CENTERLINE
CL	CLEAR
CMU	CONCRETE MASONRY UNIT
D	DEPTH
DIA	DIAMETER
DIM	DIMENSION
DL	DEAD LOAD
EA	EACH
EF	EACH FACE
EJ	EXPANSION JOINT
	ELEVATION
EOS	EDGE OF SLAB EQUAL
EQUIP	EQUIPMENT
EXP	EXPANSION
EXT	EXTERIOR
EW	EACH WAY
(F)	FUTURE
FF	FINISH FLOOR ELEVATION
FLR	FLOOR
FT	FEET
FTG GA	FOOTING
GALV	GAUGE GALVANIZED
GC	GENERAL CONTRACTOR
GLB	GENERAL CONTRACTOR GLUED LAMINATED WOOD BEAM
GSN	GENERAL STRUCTURAL NOTES
HORIZ	HORIZONTAL
HSA	HEADED STUD ANCHOR
HSS	HEADED STUD ANCHOR HOLLOW STRUCTURAL
1000	SECTION MOMENT OF INERTIA INTERNATIONAL BUILDING CODE
IBC	INTERNATIONAL BUILDING CODE
ID	INSIDE DIAMETER INTERIOR
KIP, K KLF	ONE THOUSAND POUNDS
KLF	KIP PER LINEAR FOOT
	KIP PER LINEAR FOOT STEEL ANGLE
LB	POUND
LL	LIVE LOAD
LLBB	LONG LEG BACK TO BACK LONG LEG HORIZONTAL
LLV	LONG LEG VERTICAL
LONG	LONGITUDINAL
LSL	LAMINATED STRAND LUMBER LONG SIDE HORIZONTAL LONG SIDE VERTICAL
LSH	LONG SIDE HORIZONTAL
LSV	LONG SIDE VERTICAL
MCJ	MASONRY CONTROL JOINTS
MECH	MECHANICAL
MFR NA	MANUFACTURER
NTS	NOT APPLICABLE NOT TO SCALE
OC	ON CENTER
OD	OUTSIDE DIAMETER
OPP	OPPOSITE
OSB	ORIENTED STRAND BOARD
PERP	PERPENDICULAR
PL	PLATE
PLF	POUNDS PER LINEAR FOOT
PSF PSI	POUNDS PER SQUARE FOOT
PSL	POUNDS PER SQUARE INCH PARALLEL STRAND LUMBER
PT	POST TENSIONED
QA	QUALITY ASSURANCE
QC	QUALITY ASSURANCE QUALITY CONTROL
REINF	REINFORCING
REQD	REQUIRED
RFI	REQUEST FOR INFORMATION
RS	ROUGH SAWN ROOF TOP UNIT
RTU SF	SQUARE FOOT
	SIMILAR
SPEC	SPECIFICATION
SQ	SQUARE
STD	STANDARD
STRUCT	STRUCTURE
SW	SHEAR WALL
T&B T&G	TOP AND BOTTOM TONGUE AND GROOVE
TOB	TOP OF REAM
TOC	TOP OF BEAM TOP OF CONCRETE
TOD	TOP OF DECK
TOF	TOP OF FOOTING
TOJ	TOP OF JOIST TOP OF MASONRY
TOM	TOP OF MASONRY
TOP	TOP OF PARAPET
TOS	TOP OF PARAPET TOP OF STEEL TOP OF WALL
TYP	TYPICAL
UNO	TOP OF WALL TYPICAL UNLESS NOTED OTHERWISE VERTICAL
VERT	VERTICAL
W/	WITH
W/C	WATER TO CEMENT RATIO
W/O WL	WITHOUT WINDLOAD
WP	WORK POINT
WWF	WELDED WIRE FABRIC



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SIONS	
DATE	REV
04/04/2020	1
09/09/2020	2
12/21/2020	3.1
TE OF JANCALO	
	DATE 04/04/2020 09/09/2020 12/21/2020 TE O

CENSEO SSIONAL ENGINE

PROJECT NAME

S SERVICE Avenue 2 0804  $\vec{\mathsf{z}}$ Oak awnside, East

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SHEET NAME


**GENERAL NOTES** 


SHEET SIZE

ARCH D 36" X 24"

SHEET NUMBER

G-2

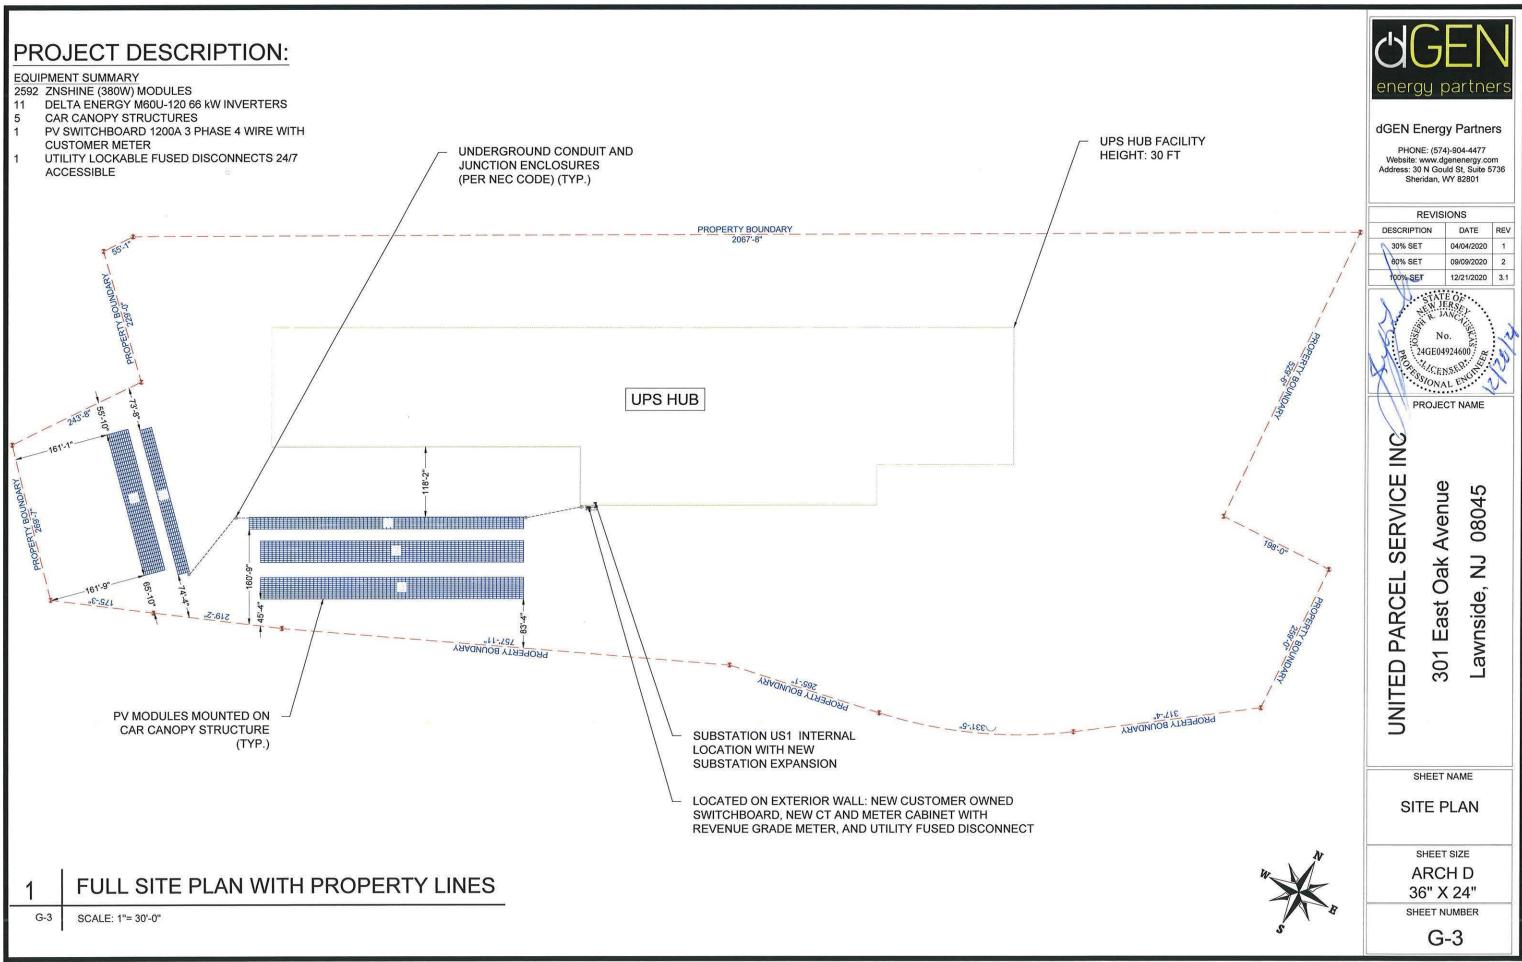

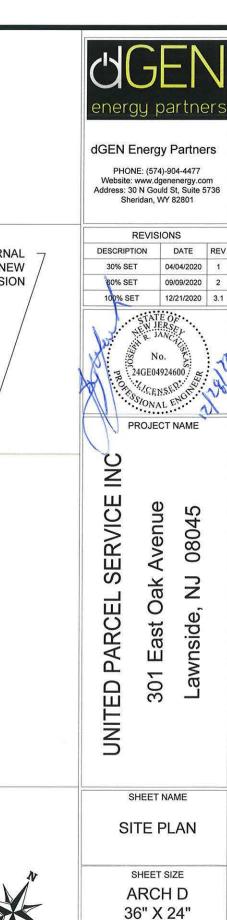

SHEET NUMBER

G-3.1

**UPS HUB** SUBSTATION US1 INTERNAL LOCATION WITH NEW SUBSTATION EXPANSION LOCATED ON EXTERIOR WALL: NEW CUSTOMER OWNED SWITCHBOARD, NEW CT UNDERGROUND CONDUIT AND AND METER CABINET WITH REVENUE GRADE JUNCTION ENCLOSURES METER, AND UTILITY FUSED DISCONNECT (PER NEC CODE) (TYP.)

SITE PLAN WITH MODULE LAYOUT

SCALE: 1"= 30'-0"

### LEGEND:

- 1 (N) (8) CANOPY MOUNTED PV INVERTERS (66 kW INVERTERS)
- 2 (N) UNDERGROUND PV PVC CONDUIT AND/OR PV EMT CONDUIT
- 3 DUMMY MODULES (NON-OPERATING)
- 4 (N) SWITCHGEAR 1200A, 480V, 3 PHASE
- 5 (N) PV AC DISCONNECT (ON EXTERIOR WALL)
- 6 (N) MAIN AC DISCONNECT 1200A FUSE IN 1200A SWITCHBOARD (ON EXTEROR WALL)
- 7 (E) SWITCHBOARD (ON INTEROR WALL)

#### **GENERAL NOTES:**

 $\bigwedge$ 

ALL EXTERIOR EQUIPMENT AT THE CUSTOMER OWNED EQUIPMENT PAD TO BE 24/7 UTILITY ACCESSIBLE INCLUDING: CT/METERING CABINET AND PV DISCONNECT.

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REVISIONS

DESCRIPTION DATE REV

30% SET 04/04/2020 1

60% SET 09/09/2020 2

100% SET 12/21/2020 3.1

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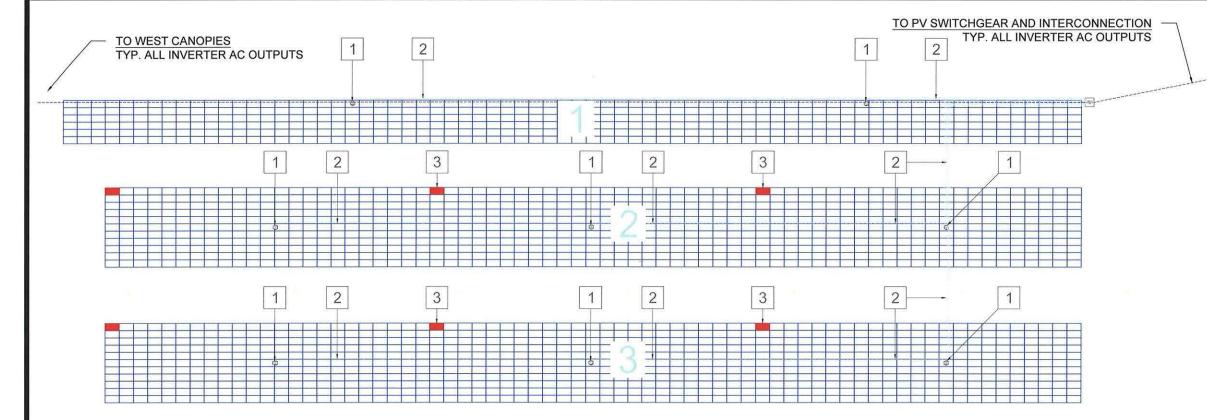
No. 24GE04924600 & SONAL ENGINEERS

PROJECT NAME

0804

3

Lawnside,



MODULE LAYOUT (EAST PARKING CANOPIES)

G-3.2 SCALE: 1"= 20'-0"

**EQUIPMENT PAD** 

PARKING CANOPIES

(AREA OF WORK)

(AREA OF WORK)

UNITED PARCEL SERVICE INC 301 East Oak Avenue

SHEET NAME

MODULE LAYOUT (EAST)

SHEET SIZE

ARCH D 36" X 24"

SHEET NUMBER

G-3.2


#### LEGEND:

- (N) (3) CANOPY MOUNTED PV INVERTERS (66 kW INVERTERS)
- NEW UNDERGROUND PV PVC CONDUIT AND/OR PV EMT CONDUIT
- DUMMY MODULES (NON-OPERATING)



#### **GENERAL NOTES:**

ALL EXTERIOR EQUIPMENT AT THE CUSTOMER OWNED EQUIPMENT PAD TO BE 24/7 UTILITY ACCESSIBLE INCLUDING: CT/METERING CABINET AND PV DISCONNECT.

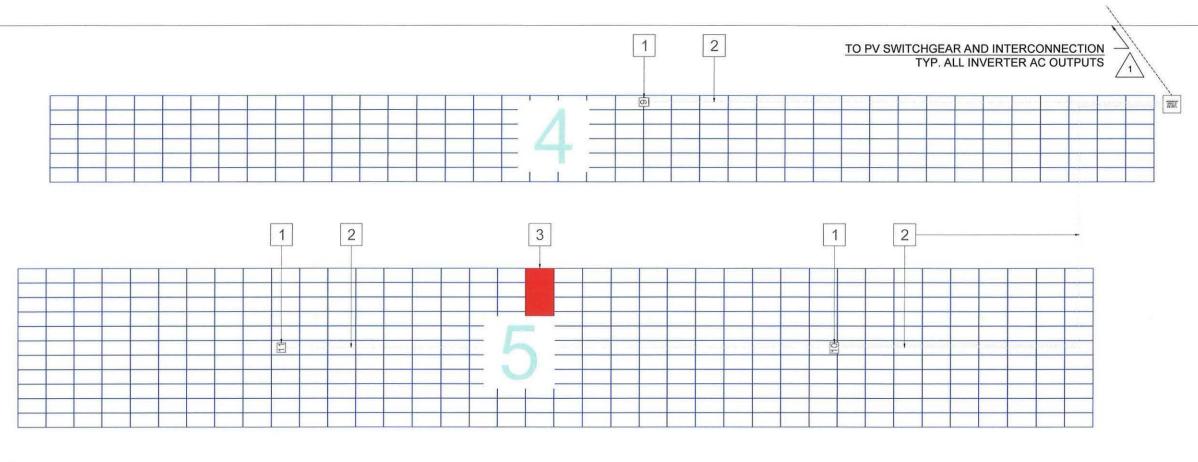

MODULE LAYOUT (WEST PARKING CANOPIES)

G-3.3

SCALE: 1"= 10'-0"



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60% SET	09/09/2020	2
100% SET	12/21/2020	3.1



08045

Z

Lawnside,

SERVICE INC East Oak Avenue UNITED PARCEL

SHEET NAME

MODULE LAYOUT (WEST)

SHEET SIZE

ARCH D 36" X 24"

SHEET NUMBER

G-3.3

#### PROPOSED INVERTER **IEEE1547 RELAY SETTINGS** DEVICE PICKUP TIME DELAY DESCRIPTION NOTE(S) 1.1 SEC 139V UNDERVOLTAGE RELAY 2.0 SEC 244V

OVERVOLTAGE

RELAY

OVER/UNDER-

**FREQUENCY** 

2.0 SEC

0.16 SEC

0.16 SEC

300 SEC

300 SEC

0.16 SEC

SITE DETAILS	<b>i</b>
AC NAMEPLATE (kW)	726.00
AC NAMEPLATE (kVAR)	~0
DC NAMEPLATE (kW)	984.96
MODULES	2592
INVERTERS	11
STRINGS	144

PV EQUIPMENT NOTES	
MODULE	

ZNShine ZXM6-72-380/M RATED POWER (W): 380 Isc (A): 10.03 Voc (V): 48.6 Imp (A): 9.53 Vmp (V): 39.9 UL 1703 LISTED

### **INVERTER**

DELTA ENERGY M60U-120 POWER (kW): 66 lac (A): 80 Vac (V): 480 UL 1741 LISTED

#### **GENERAL NOTES:**




ALL EQUIPMENT AT THE CUSTOMER OWNED EQUIPMENT PAD TO BE 24/7 UTILITY ACCESSIBLE INCLUDING: PV SWITCHGEAR AND PV DISCONNECT.





EXISTING CUSTOMER MEDIUM VOLTAGE GEAR NOT PICTURED, REFER TO FACILITY SINGLE LINE FOR DETAILS



SEVERAL CANOPIES HAVE MODULES THAT ARE NOT ELECTRICALLY CONNECTED IN ORDER TO COMPLETE THE ROOF STRUCTURE OF THE CANOPY. CANOPY 2 HAS 3 BLANK MODULES. CANOPY 3 HAS 3 BLANK MODULES. CANOPY 5 HAS 4 BLANK MODULES.

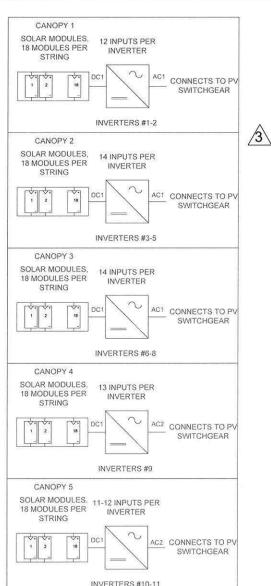

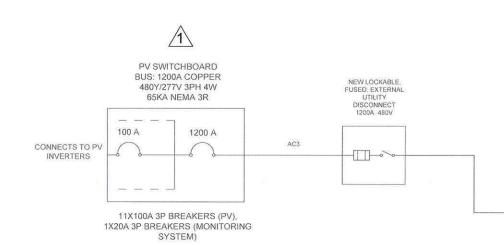

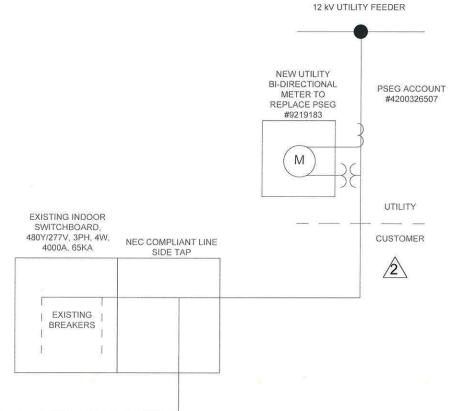

ROJECT ROJECT PROJECT NAME S SERVICE Avenue Oak PARCEL East 301 UNITED SHEET NAME SINGLE LINE DIAGRAM

dGEN Energy Partners

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Sheridan, WY 82801

**REVISIONS** 

DATE

04/04/2020

09/09/2020

12/21/2020 3.1

08045

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awnside,

SHEET SIZE ARCH D

36" X 24" SHEET NUMBER

PV-1

REV

DESCRIPTION

30% SET

60% SET

100% SET





PV-1

27-1

27-2

59-1

59-2

81U-1

810-1

810

304V

332V

56.5 HZ

61.0 HZ

62.0 HZ

81U-2 58.5 HZ

SCALE: N.T.S.

				POWER	R FEEDER SCH	EDULE				
INDENTIFIER	CONDUCTOR SIZE	CONDUCTOR TYPE	NEUTRAL	INSULATION TYPE	GROUND SIZE	GROUND TYPE	GROUND INSULATION	CONDUIT	FEEDER SETS PER CIRCUIT	CURRENT
DC1	#10 AWG PER RACEWAY	COPPER	NA	PV WIRE 2KV	(1) #6 AWG	COPPER	XHHW-2	1.25 INCH EMT	1	
AC1	(3) 1/0 AWG PER RACEWAY	COPPER	1/0 AWG	XHHW-2	(1) #4 AWG	COPPER	XHHW-2	2 INCH EMT	1	100
AC2	(3) 4/0 AWG PER RACEWAY	COPPER	4/0 AWG	XHHW-2	(1) 2/0 AWG PER RACEWAY	COPPER	XHHW-2	2.5 INCH EMT	1	100
AC3	(3) 350KCMIL AWG PER RACEWAY	COPPER	4/0 AWG	XHHW-2	(1) 2/0 AWG PER RACEWAY	COPPER	XHHW-2	2.5 INCH EMT	4	1200

#### **GENERAL NOTES:**

 1.ALL VALUES IN POWER FEEDER SCHEDULE TO BE CONFIRMED BY CONTRACTOR.
 2.ROOF CIRCUIT LENGTHS ARE NOT LONG ENOUGH TO CREATE SIGNIFICANT VOLTAGE DROP AT 480V.
 3.ALL CONDUCTOR SIZES ARE NEC COMPLIANT.



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DESCRIPTION	DATE	REV
30% SET	04/04/2020	1
60% SET	09/09/2020	2
100% SET	12/21/2020	3.1

No. \$24GE04924600 & SONAL ENGLAND

PROJECT NAME

SERVICE INC k Avenue

301 East Oak Avenue Lawnside, NJ 08045

SHEET NAME

UNITED PARCEL

SCHEDULES


SHEET SIZE

ARCH D 36" X 24"

SHEET NUMBER

#### **EQUIPMENT PAD NOTES**

- 1. BOLLARDS TO HAVE 4 INCH DIAMETER.
- 2. BOLLARDS THAT ARE IN FRONT OF EQUIPMENT DOORS TO BE REMOVABLE, ALLOWING FOR THE EQUIPMENT PAD TO BE ABUTTING THE BOLLARDS.
- UPS TO PROVIDE APPROVED SHOP DRAWINGS OF AC GEAR AT A LATER DATE. CURRENT DRAWINGS BASED ON QUOTED EQUIPMENT BY SCHNEIDER ELECTRIC.
- CONCEPTUAL PAD AND CONCRETE TO HAVE 4000PSI 28 DAY COMPRESSIVE STRENGTH MINIMUM.
- UTILITY COMPANY HAS NOT CONFIRMED ALL **EQUIPMENT THAT IS REQUIRED FOR** INTERCONNECTION. THIS WILL BE DETERMINED AT A LATER DATE.
- CONTRACTOR SHALL PROVIDE SIGNED AND SEALED **ENGINEERING SHOP DRAWINGS FOR STRUCTURAL** EQUIPMENT PAD APPROVED BY CALIFORNIA LICENSED

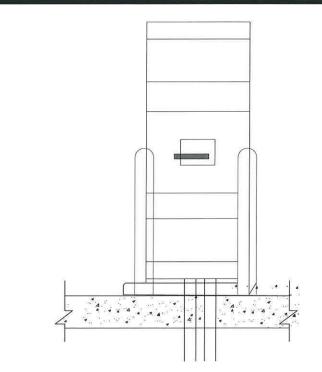


**EQUIPMENT PAD - AC UTILITY DISCONNECT** 

**CONCRETE PAD DETAIL** 

PV-3

3

PV-3

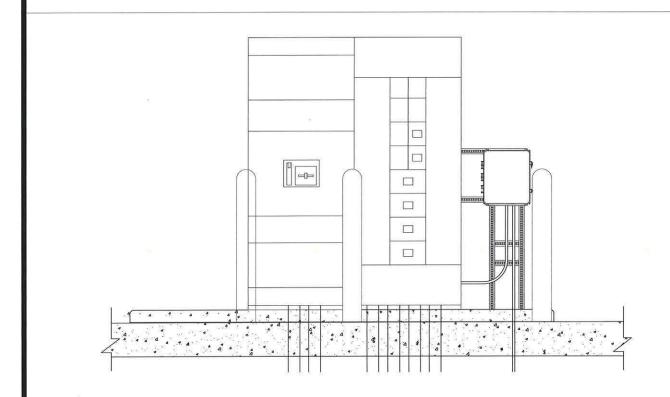

**EQUIPMENT PAD - SWITCHGEAR** 

SCALE: 1/16"= 1'-0"

PV-3

3/4" CHAMFERED EDGE (TYP.) SURFACE TO BE BROOM SWEPT #4 REBAR 12" OC EACH WAY. REBAR SHALL BE GRADE 60 (60KSI) **GRAVEL TO BE 3/4" DIAMETER** MAXIMUM AGGREGATE SIZE

dGEN Energy Partners

PHONE: (574)-904-4477

**REVISIONS** 04/04/2020 30% SET 12/21/2020 3.1

PROJECT NAME

NJ 08045

Lawnside,

SERVICE INC East Oak Avenue, UNITED PARCEL 301

SHEET NAME

**Equipment Pad** Detail


SHEET SIZE

ARCH D 36" X 24"


SHEET NUMBER

#### **EQUIPMENT PAD NOTES**

1. CONCRETE PAD MOUNTING DETAIL TYPICAL AND MOUNTING PLATE MAY VARY BY EQUIPMENT. REFER TO MANUFACTURER MOUNTING AND ANCHORING REQUIREMENTS FOR ADDITIONAL DETAILS. IN THE EVENT OF CONFLICT, MANUFACTURER REQUIREMENTS WILL PREVAIL IF MORE STRINGENT THAN DESIGN SHOWN IN THIS DETAIL.

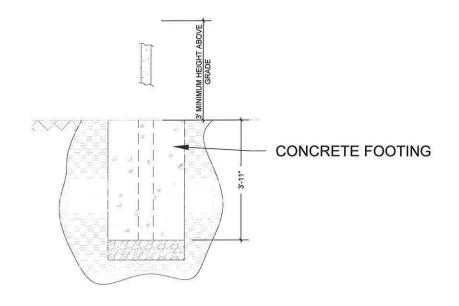

2 PIPE BOLLARD TYPICAL

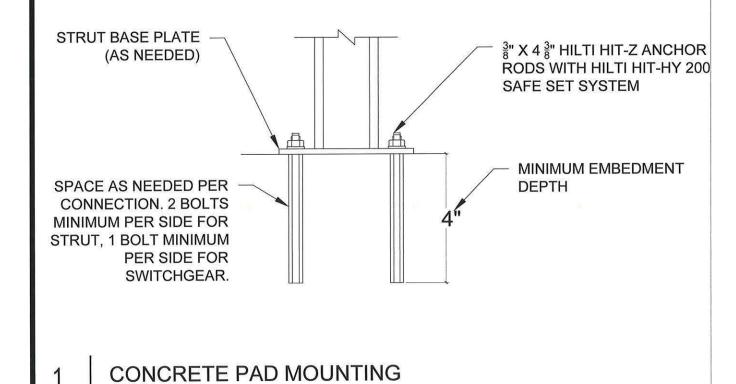

SCALE: 1/16"= 1'-0"

PV-4



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REVIS	SIONS	
DESCRIPTION	DATE	REV
30% SET	04/04/2020	1
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100% SET	12/21/2020	3.1

# No. 24GE04924600

#### PROJECT NAME

301 East Oak Avenue, Lawnside, NJ 08045

PARCEL

UNITED

SHEET NAME

Additional Detail


SHEET SIZE

ARCH D


36" X 24"


#### **INVERTER MOUNTING NOTES**


Inverter mounting diagrams supplied by Delta Electronics. Contractor to use Delta Inverter Mount supplied by Delta Electronics.

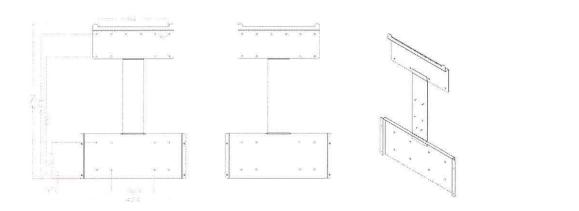


**BRACKET** 

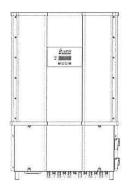

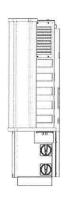

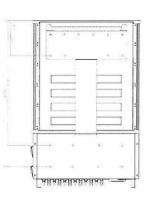

**INVERTER** 

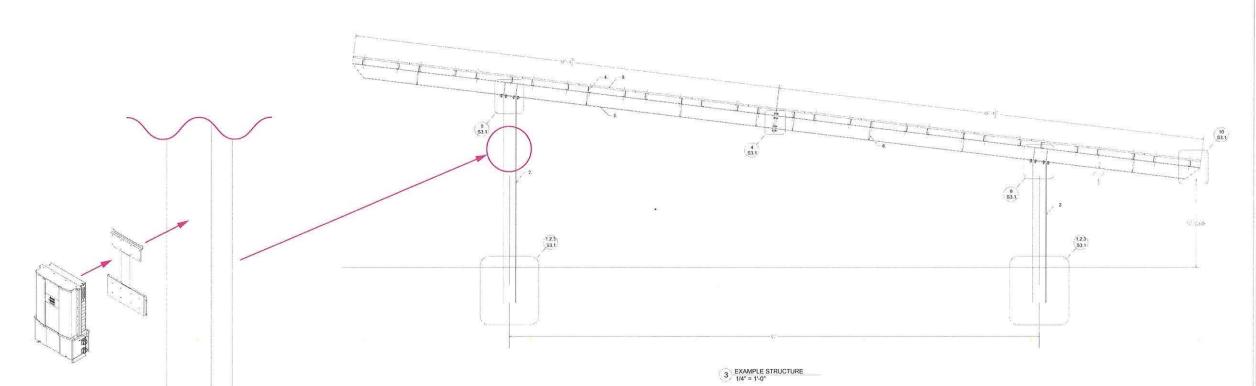

**INVERTER MOUNTING** 

PV-5

SCALE: 1/16"= 1'-0"

UNITED PARCEL SERVICE INC

dGEN Energy Partners

PHONE: (574)-904-4477

Website: www.dgen.energy

REVISIONS

PROJECT NAME

301 East Oak Avenue,

Lawnside, NJ 08045

04/04/2020 1 09/09/2020 2 12/21/2020 3.1

DESCRIPTION

SHEET NAME

Inverter Mounting

ARCH D 36" X 24"

SHEET NUMBER

## WARNING

#### **ELECTRIC SHOCK HAZARD**

IF A GROUND FAULT IS INDICATED NORMALLY GROUNDED CONDUCTORS MAY BE UNGROUNDED AND ENERGIZED

LABEL LOCATION: DC DISCONNECT, INVERTER (PER CODE: NEC 690.35(F)) [To be used when inverter is ungrounded]

#### **ELECTRIC SHOCK HAZARD**

THE DC CONDUCTORS OF THIS PHOTOVOLTAIC SYSTEM ARE INGROUNDED AND MAY BE ENERGIZED

LABEL LOCATION: DC DISCONNECT, INVERTER (PER CODE: NEC 690.35(F)) [To be used when inverter is ungrounded]

**ELECTRIC SHOCK HAZARD** DO NOT TOUCH TERMINALS TERMINALS ON BOTH LINE AND LOAD SIDES MAY BE ENERGIZED IN THE

**OPEN POSITION** 

DC VOLTAGE IS ALWAYS PRESENT WHEN SOLAR MODULES ARE **EXPOSED TO SUNLIGHT** 

AC DISCONNECT, POINT OF INTERCONNECTION (PER CODE: NEC 690.17(E))

## WARNING - Electric Shock Hazard

No user serviceable parts inside Contact authorized service provider for assistance

(PER CODE: NEC690.13.G.3 & NEC 690.13.G.4)

#### WARNING: PHOTOVOLTAIC **POWER SOURCE**

LABEL LOCATION: CONDUIT, COMBINER BOX (PER CODE: NEC690.31(G)(3)(4) & NEC 690.13(G)(4)

#### PHOTOVOLTAIC SYSTEM AC DISCONNECT RATED AC OPERATING CURRENT 1200 AMPS AC NOMINAL OPERATING VOLTAGE 480 VOLTS

LABEL LOCATION: AC DISCONNECT, POINT OF INTERCONNECTION (PER CODE: NEC690.54)

#### WARNING INVERTER OUTPUT CONNECTION DO NOT RELOCATE THIS OVERCURRENT DEVICE

LABEL LOCATION: POINT OF INTERCONNECTION (PER CODE: NEC 705.12(D)(7))

(Not required if panelboard is rated not less than sum of ampere ratings of all overcurrent devices supplying it?

## CAUTION: SOLAR CIRCUIT

MARKINGS PLACED ON ALL INTERIOR AND EXTERIOR DC CONDUIT, RACEWAYS, ENCLOSURES. AND CABLE ASSEMBLIES AT LEAST EVERY 10 FT, AT TURNS AND ABOVE/BELOW PENETRATIONS AND ALL COMBINER/JUCTION BOXES. (PER CODE: IFC605.11.1.4)

## SOLAR DISCONNECT

LABEL LOCATION:
DISCONNECT, POINT OF INTERCONNECTION (PER CODE: NEC690.13(B))

WARNING DUAL POWER SOURCE ECOND SOURCE IS PHOTOVOLTAIC SYSTE

POINT OF INTERCONNECTION (PER CODE: NEC 705.12(D)(4))

#### CAUTION: SOLAR ELECTRIC SYSTEM CONNECTED


#### LABEL LOCATION:

WEATHER RESISTANT MATERIAL, DURABLE ADHESIVE, UL969 AS STANDARD INVERTER, JUNCTION BOXES (ROOF), AC DISCONNECT TO WEATHER RATING (UL LISTING OF MARKINGS NOT REQUIRED), MIN 3/8" LETTER HEIGHT ARIAL OR SIMILAR FONT NON-BOLD, PLACED WITHIN THE MAIN SERVICE DISCONNECT, PLACED ON THE OUTSIDE OF THE COVER WHEN DISCONNECT IS OPERABLE WITH SERVICE PANEL CLOSED. (PER CODE: NEC690.15, 690.13(B))

#### INVERTER #1 - #11 (M60U-120)

RATED MAXIMUM POWER-133.42 POINT CURRENT (Imp) 718.2 POINT VOLTAGE (Vmp) MAXIMUM SYSTEM 874.8 **VOLTAGE (VOC)** 140.4

LABEL LOCATION: DC DISCONNECT, INVERTER (PER CODE: NEC690.53)

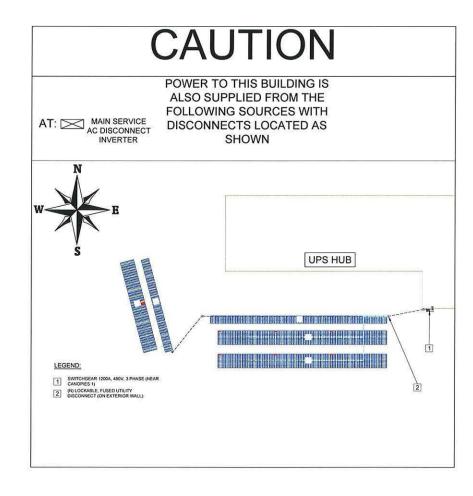

#### ADHESIVE FASTENED SIGNS:

- THE LABEL SHALL BE SUITABLE FOR THE ENVIRONMENT WHERE IT IS INSTALLED.
- · WHERE REQUIRED ELSEWHERE IN THIS CODE, ALL FIELD APPLIED LABELS, WARNINGS, AND MARKINGS SHOULD COMPLY WITH ANSI Z535.4 [NEC 110.21(B) FIELD MARKING1.
- · ADHESIVE FASTENED SIGNS MAY BE ACCEPTABLE IF PROPERLY ADHERED. VINYL SIGNS SHALL BE WEATHER RESISTANT [IFC 605.11.1.3]



#### dGEN Energy Partners

PHONE: (574)-904-4477 Website: www.dgen.energy

DESCRIPTION		DATE	REV
30%	SET	04/04/2020	1
60%	SET.	09/09/2020	2
1009	SET	12/21/2020	3.1

# CENSED OF

PROJECT NAME

2

0804

3

SERVICE Avenue Oak awnside, East 301

**PARCEI** 

UNITED

SHEET NAME

**PLACARDS** 

SHEET SIZE

ARCH D 36" X 24"

SHEET NUMBER

PV-6

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